ALLOWABLE DEFLECTION OF STRUCTURAL MEMBER

STRUCTURAL MEMBER	ALLOWABLE DEFLECTION
RAFTER HAVING SLOPES GREATER THAN 3/12 WITH NO FINISHED CEILING ATTACHED TO RAFTERS	L/180
INTERIOR WALLS AND PARTITIONS	H/180
FLOORS AND PLASTERED CEILINGS	L/360
ALL OTHER STRUCTURAL MEMBERS	L/240
EXTERIOR WALLS WITH PLASTER OR STUCCO FINISH	H/360
EXTERIOR WALLS WIND LOADS WITH BRITTLE FINISHES	L/240
EXTERIOR WALL WIND LOAD WITH FLEXIBLE FINSIHES	L/120

JOHN'S RESIDENCE

196 WILMONT ROAD, NEW ROCHELLE, NY, 10804

REQUIREMENTS TO IDENTIFY THE USE OF TRUSS TYPE CONSTRUCTION

PRE-ENGINEERED WOOD CONSTRUCTION AND/OR TIMBER CONSTRUCTION

SECTION 1265.4 SIGN OR SYMBOL

(A) EACH NEW RESIDENTIAL STRUCTURE AND EACH ADDITION TO OR REHABILITATION OF AN EXISITING RESIDENTIAL STRUCTURE THAT UTILIZES TRUSS TYPE CONSTRUCTION, PRE-ENGINEERED WOOD CONSTRUCTION AND/OR TIMBER CONSTRUCTION SHALL BE IDENTIFIED BY A SIGN OR SYMBOL IN ACCORDANCE WITH THE PROVISIONS OF THIS PART.

(B) THE SIGN OR SYMBOL REQUIRED BY THIS PART SHALL BE AFFIXED TO THE ELECTRIC BOX ATTACHED TO THE

EXTERIOR OF THE RESIDENTIAL BUILDING; PROVIDE HOWEVER THAT:

(1) IF AFFIXING THE SIGN OR SYMBOL THE ELECTRIC BOX WOULD OBSERVE ANY METER ON THE ELECTRIC BOX,

OR IF THE UTILTIY PROVIDING ELECTRIC SERVICE TO THE RESIDENTIAL STRUCTURE DOSE NOT ALLOW THE SIGN OR

SYMBOL TO BE AFFIXED TO THE ELECTRIC BOX. THE SIGN OR SYMBOL SHALL BE AFFIXED TO THE EXTERTIOR WALL OF

THE RESIDENTAIL STRUCTURE AT A POINT IMMEDIATELY ADJACENT TO THE ELECTRIC BOX; AND

2) IF NO ELECTRIC BOX IS ATTACHED THE EXTERIOR OF THE RESIDENTAIL STRUCTURE OR IF, IN THE OPINION OF THE LUTHORITY HAVING JURISDICTION, THE ELECTRIC BOX ATTACHED TO THE EXTERTIOR OF THE BUILDING IS NOT LOCATED IN A PLACE LIKELY TO BEEN SEEN BY FIREFIGHTERS OR OTHER FIRST RESPONDERS RESPONDING TO A FIRE OR OTHER

(c)THE SIGN OR SYMBOL REQUIRED BY THIS PART SHALL BE AFFIXED PRIOR TO THE ISSUANCE OF THE CERTIFICATE OF OCCUPANCY OR A CERTIFICATE OF COMPLIANCE. THE AUTHORITY HAVING JURSDICTION SHALL NOT ISSUE A CERTIFICATE OF OCCUPANCY OR CERTIFICATE OF COMPLIANCE UNTIL THE SIGN OR SYMBOL REQUIRED BY THIS PART

(D)THE PROPERTY OWNER SHALL BE RESPONSIBLE FOR MAINTAING THE SIGN OR SYMBOL REQUIRED BY THIS PART AND SHALL PROMPTLY REPLACE ANY SUCH SIGN OR SYMBOL THAT IS AFFIXED TO AN ELECTRIC BOX WHEN ANY CHANGE OR MODIFICATION IS MADE TO SUCH ELECTRIC BOX. THE RPOPERTY OWNER SHALL PROMPTLY REPLACE THE SIGN IR SYMBOL REQUIRED BY THIS PART IF SUCH SIGN OR SYMBOL IS REMOVED OR BECOMES DAMAGED, FADED, WORN OR OTHERWISE LESS CONSPICUOUS TO FIREFIGHTERS OR OTHER FIRST RESPONDERS RESPONDING THE A FIRE OR OTHER EMERGENCY AT THE RESIDENTIAL STUCTURE. THE PROPERTY OWNER SHALL KEEP THE AREA IN THE VICNITY OF THE SIGN OR SYMBOL REQUIRED BY THIS PART CLEAR OF ALL PLANTS, VEGETATION, AND OTHER OBSTRUCTION THAT MAY HIDE OR OBSCURE SUCH SIGN OR SYMBOL OR OTHERWISE CAUSE SUCH SIGN OR SYMBOL TO BE LESS CONSPICIOUS TO FIREFIGHTERS OR THE OTHER FIRST RESONDING TO A FIRE OR THE OTHER EMERGENCY AT THE RESIDENTIAL STRUCTURE

(E) THE SIGN OR SYMBOL INCDICATING OF TRUSS TYPE CONSTRUCTION, PRE-ENGINEERED WOOD CONSTRUCTION AND/OR TIMBER CONSTRUCTION SHALL COMPLY WITH THE REQUIREMENTS OF THE SUBDIVISION. (1) THE SIGN OR SYMBOL SHALL CONSIST OF A CIRCLE SIX INCHES (152.4MM) IN DIAMETER, WITH A STROKE WIDTH OF 1/2 INCH (12.7MM). THE BACKGROUND OF THE SIGN OR SYMBOL SHALL BE REFLECTIVE WHITE IN COLOR. THE CIRCLE AND CONTENTS SHALL BE REFLECTIVE RED IN COLOR, CONFORMING TO PANTONE MATCHING SYSTEM (PMS) #187.

(2) THE SIGN OR SYMBOL SHALL BE OF STURDY, NON-FADING, WEATHER RESISTANT MATERIAL; PROVIDED, HOWEVER, THAT A SIGN OR SYMBOL APPLIED DIRECTLY TO A DOOR OR SIDELIGHT MAYBE A PERMANENT NON FADING STICKER OR DECAM

(3) THE SIGN OR SYMBOL SHALL CONTAIN AN ALPHABETIC CONSTRUCTION DESIGNATION TO INDICATE THE

CONSTRUCTION TYPE OF RESIDENTIAL STRUCTURE, AS FOLLOW:
(I) IF THE RESIDENTIAL STRUCTURE IS SUBJECT TO THE PROVISION OF THE RCNYS, THE CONSTRUCTION TYPE

DESIGNATION SHALL BE "V" AND
(II) IF THE RESIDENTIAL STRUCTURE IS SUBJECT TO THE PROVISION OF THE BCNYS, THE CONSTRUCTION TYI

DESIGNATION SHALL BE "I", "III", "IV", OR "V" TO INDICATE THE CONSTRUCTION CLASSIFICATION OF THE STRUCTURE UNDER SECTION 602 OF THE BCNYS.

(4) THE SIGN OR SYMBOL SHALL CONTAIN AN ALPHABETIC LOCATION DESIGNATION TO INDICATE THE LOCATION (S) CONTAINING TRUSS TYPE CONSTRUCTION, PRE-ENGINEERED WOOD CONSTRUCTION AND/OR TIMBER CONSTRUCTION STRUCTURAL COMPONENTS AS FOLLOWS:

STRUCTURAL COMPONENTS AS FOLLOWS:
(I) "F" SHALL MEAN FLOOR FRAMING INCLUDING GIRDERS AND BEAMS;

(II) "R" SHALL MEAN ROOF FRAMING; AND

(III) "FR" SHALL MEAN FLOOR FRAMING AND ROOF FRAMING.

(5) THE CONSTRUCTION TYPE DESIGNATION, WHICH SHALL BE PLACED AT THE SIX O'CLOCK POSITION OF THE SIGN OR SYMBOL.



AREA ANALYSIS:

1ST FLOOR=

GARAGE=
REAR DECK=
FRONT PORTICO=

TOTAL FIRST FLOOR=
TOTAL SECOND FLOOR=

SEAL:

CLIMATIC GEOGRAPHIC DESIGN CRITERIA

					[REFER	TO TABLE R301.2(1) OF THE RE	SIDENTIAL CODE OF NE	EW YORK STATE]					
GROUND					SIESMIC DESIGN	SUI	BJECT TO DAMAGE FRO	M	WINTER — DESIGN	ICE SHIELD UNDERLAYMENT	FLOOD HAZARD	AIR FREEZING	MEAN ANNUAL
SNOW LOAD	SPEED (MPH)	TOPOG RAPHIC EFFECTS k	SPECIAL WIND REGION	BORNE-BRONE DEBRIS	CATEGORY	WEATHERING	FROST LINE DEPTH	TERMITE	TEMP	REQUIRED	IIAZAKU	INDEX	TEMP
20 PSF	13vult	NO	NO	I MILE FROM THE COAST	В	SEVERE	3 FEET BOF	MODERATE TO HEAVY	15°	YES	CONTACT BLDG DEAPRTMENT	599	51°

MINIMUM UNIFORM DISTRIBUTED DESIGN LOADS

USE	LIVE LOAD	DEAD LOAD
EXTERIOR BALCONIES	60 PSF	10 PSF
DECKS	40 PSF	10 PSF
PASSENGER VEHICLE GARAGES	50 PSF	AS PER PLAN
ATTICS WITHOUT STORAGE (ROOF BELOW 3 PITCH)	10 PSF	10 PSF
ATTICS WITH STORAGE (ROOF BELOW 3 PITCH)	20 PSF	10 PSF
ROOMS OTHER THAN SLEEPING ROOMS	40 PSF	10 PSF
SLEEPING ROOMS	30 PSF	10 PSF
STAIRS	40 PSF	10 PSF
GUARDRAIL AND HANDRAILS	200 PSF	10 PSF
ROOF LOADING (LIVE= GROUND SNOW LOAD ADJUSTMENTS AS PER TABLE R301.5 OF THE RESIDENTIAL CODE OF NEW YORK STATE	45 PSF	12 PSF FOR ATTIC 15PSF FOR CATH

DRAWINGS:

1 TITLE SHEET
2 NOTES & DETAILS

3 CELLAR PLAN

4 1ST & 2ND FLOOR PLAN

5 ROOF PLAN

6 CROSS SECTIONS

7 ELEVATION (1)

8 ELEVATIONS (2)

9 ELECTRICAL PLAN

10 INTERIOR ELEVATIONS

11 SCHEDULES & DETAILS

ZONNING ANALYSIS

ISSUE	REQUIRED	PROPOSED
LOT SIZE	8,355.00 SF	8,355.00 SF
MAX.BLDG HEIGHT	30'-0"	28'-11 1/2"
MIN. FRONT YARD	25'	25'
2ND FRONT YARD	35.8'	25'
SIDE YARD AGG.	11.9'	42'
SIDE YARD MIN	11.9'	17'
MIN. REAR YARD	25'-0"	25'-0"
REAR YARD ENCROACHMENT	240 SF	ONE STORY DWELLING= 108 SF REAR DECK = 90 SF

DESIGN GROUP LLC

John's Residence

PROJECT INFO: PROJECT NO 455668	SI ARCHITECT SI ARCHITECTURE GROUP L	Sheet Na	ime	
CLIENT INFO:	DRAWN BY:	REVISIONS:		
CLIENT NAME JOHN	IHSANULLAH SAIBAY		SCALE:	1/8"

GENERAL NOTES:

- NO WORK IS TO START UNTIL A PERMIT IS OBTAINED FROM THE BUILDING DEPARTMENT
- ALL WORK SHALL CONFORM WITH N.Y.S UNIFORM FIRE PREVENTION AND BUILDING CODE, 2015 IRC, 2017 UNIFORM CODE SUPPLEMENT AS WELL AS ALL OTHER CODES REFRENCED THEREIN, AND LOCAL BUILDING CODES.
- ALL UNNOTED OR NONVISIBLE EASEMENTS OR CONDITION WHICH SHALL ARISE DURING THE COURSE OF CONSTRUCTION THAT DISAGREES WITH THAT INDICATED IN THESE PLANS SHALL CAUSE THE CONTRACTOR TO STOP AND NOTIFY
- THE ARCHITECT OF ENGINEE. SHOULD HE FAIL TO FOLLOW THIS PROCEDURE AND CONTINUE TO WORK HE WILL THEN ASSUME ALL RESPONSIBILITY AND LIABILITY ARISING THEREFROM.
- NO DEVIATION OR CHANGES TO ANY PART OF THESE PLANS SHALL BE MADE UNLESS FIRST APPROVED BY THE ARCHITECT, ENGINEER, AND BUIDLING DEPARTMENT DRY WELLS AS REQUIRED BY STATE AND LOCAL CODES
- ALL DIMENSIONS HEREIN ARE APPROXIMATE NOT TO BE SCALED AND ARE SUBJECT TO REVISION AS PER ACTUAL FIELD CONDITIONS. THE DISCRETION OF THE OWNER, AND AS DIRECTED AND/OR APPROVED BY ARCHITECT OR ENGINEER.
- OWNER/CONTRACTOR ARE RESPONSIBLE TO OBTAIN INSPECTIONS, APPROVALS, CERTIFICATES, CERTIFICATE OF OCCUPANCY/ COMPLETION AND U.L APPROVAL.
- THIS SET OF PLANS IS THE PROPERTY OF "SI DESIGN GROUP LLC" AND IS FOR ONE PROJECT NOTED HEREIN ONLY (EVEN IF THIS PROJECT IS NOT CONSTRUCTED. THE PLANS SHALL NOT BE ALTERED, REPRODUCED OR USED IN ANY WAY WITH WRITTEN PERMISSION OR COMPENSATION OF SI DEISGN GROUP LLC.
- THE ARCHITECT OR ENGINEER IS NOT RETAINED FOR SUPERVISION OF WORK AND IS RESPONSIBLE FOR DESIGN INTENT ONLY.
- 10. ANY MATERIAL OR WORKMANSHIP FOUND AT ANY TO BE DEFECTIVE SHALL BE REMEDIED AT ONCE REGARDLESS OF ANY PREVIOUS INSPECTIONS.
- CONTRACTOR SHALL BE FAMILIAR WITH CURRNET GENERAL REQUIREMENTS OF ALL STANDARD AND SPECIATY SYSTEM / MATERIALS USED WITHIN THIS PROJECT WITH THE MOST STRINGENT RECOMMENDATIONS / REQUIREMENTS TO BE FOLLOWED.
- 12. IT IS THE INTENT OF THESE PLANS TO EXPLAIN THE REQUIREMENTS OF THE PROPOED CONSTRUCTION. HOWEVER FIELD CONDITIONS MAY ARISE DURING CONSTRUCTION THAT MAY NOT HAVE BEEN EXHAUSTIVELY DETAILED.
- 13. ANY AND ALL DISCREPANCIES TO BE REPORTED TO ENGINEER
- 14. WALL AND CEILING FINISHES SHALL BE IN ACCORDANCE WITH SECTION R701 AND INSULATION SHALL BE IN ACCORDANCE WITH SECTION R316.
- 15. INTERIOR WALL COVERING SHALL BE IN ACCORDANCE WITH SECTION R702 AND EXTERIOR WALL COVERING SHALL BE IN ACCORDANCE WITH SECTION R703.
- 16. THE PROJECT COMPLIES WITH/ THE 2015 INTERNATION RESIDENTIAL CODE 2ND PRINTING AND 2017 NYS SUPPLEMENT.

MECHANICAL SYSTEM COMPLIES WITH CHAPTER 12 THROUGH 23, PLUMBING SYSTEM COMPLIED WITH CHAPTER 24 THROUGH CHAPTER 32, ELECTRICAL SYSTEM COMPLIES CHAPTER 34 THROUGH CHAPTER 43.

CARPENTRY:

- ALL LUMBER SHALL BE D.F. #2 OR BETTER UNLESS OTHERWISE NOTED (U.O.N.)
- ALL LUMBER TO BE A MINIMUM OF 8" ABOVE FINISHED GRADE. (U.O.N.)
- SILLS TO BE FLASHED (TERMITE SHIELD) W/ SILL SEAL. SILL TO BE A.C.Q. WOOD 2- 2" x 6" U.O.N.
- ALL JOISTS HANGERS TO BE "TECO" OR EQUAL, FULL SIZE.
- DOUBLE HEADERS AND TRIMMERS ABOUT ALL OPENINGS. (U.O.N.)
- DOUBLE JOISTS UNDER PARALLEL PARTITIONS, POSTS, AND BATH TUBS. (U.O.N.) ALL BEAMS, GIRDERS, HEADERS, ETC. TO HAVE A MINIMUM OF 4" BEARING.
- ALL WINDOWS TO BE IN CONFORMANCE W/ ATTACHED ENERGY STATEMENT W/ MODELS NUMBERS ON PLANS.
- PROVIDE ATLEAST (1) WINDOW (OR DOOR) IN EACH HABITABLE SPACE FOR EMERGENCY ESCAPE. IN CONFORMANCE WITH 2015 I.R.C 2ND PRINTING & 2017 SUPPLEMENTAL SEC. R310 MIN OPENING OF 5.7 SQ. FEET (5.0 SQ. FEET @ GRADE LEVEL WHEN GRADE TO SILL IS LESS THAN 44" OR LESS) W/ MINIMUM NET HEIGHT 24" AND MINIMUM NET WIDTH OF 20" (OPERATION W/O NEED FOR TOOLS) BOTTOM OF OPENING @ 44" MAXIMUM A.F.F.
- EXTERIOR WINDOWS ARE TO BE DESIGNED IN ACCORDANCE WITH SECTION R609. ALL GLAZING SHALL COMPLY WITH SECTION R308.
- STAIRWAYS SHALL BE DESIGNED IN ACCORDANCE WITH SECTIONS R311.5 TO R311.5.7 12. MOISTURE VAPOR BARRIER IS TO BE INSTALLED ON THE WARM-IN-WINTER SIDE OF THE INSULATION IN ALL FRAMED WALLS, FLOORS, ROOF AND CEILINGS COMPRISING
- ELEMENTS OF THE BUILDING THERMAL ENVELOPE IN ACCORDANCE WITH SECTION N1102. 13. ASPHALT SHINGLES ARE TO BE INSTALLED IN ACCORDANCE WITH SECTION R905.2.

ELECTRICAL:

- ALL NEWLY INSTALLED ELECTRICAL WORK OR APPLIANCES SHALL CONFORM TO THE 2015 INTERNATIONAL RESIDENTIAL CODE 2ND PRINTING & 2017 SUPPLEMENTAL SECTIONS FOR ELECTRICAL CODE OF NEW YORK STATE.
- CONTRACTOR WILL FURNISH A FIRE UNDERWRITERS CERTIFICATE UPON COMPLETION OF WORK.
- ELECTRICAL WIRING AND EQUIPMENT TO COMPLY W/ CHAPTERS 34-43 AND LOCAL BUILDING DEPARTMENT.
- SMOKE DETECTION AS PER N.Y.S. CODE SECTION R314.
- ALL SMOKE DETECTORS SHALL BE INTERCONNECTED AND HARD WIRED.
- EXHAUST FOR THE CLOTHES DRYER SHALL BE IN ACCORDANCE WITH SECTION M1502. THE EXISTING ELECTRICAL SYSTEM SHALL BE CAPABLE OF HANDLING THE IMPOSED LOADS OF PROPOSED ADDITION. IF NOT, SYSTEM SHALL BE UPGRADED TO MEET CODE COMPLIANCE.

GENERAL NOTE:

THE PROPOSED DWELLING HAS BEEN DESIGNED TO BE IN CONFORMANCE WITH THE 2015 INTERNATION RESIDENTIAL CODE 2ND PRINTING ADOPTED AND AMENDED BY NEW YORK STATE AND THE 2017 NEW YORK STATE SUPPLEMENT

MECHANICAL NOTE:

THIS PROJECT SHALL COMPLY WITH THE MECHANICAL CODE OF NY. STATE CHAPTER 12 THROUGH 24. THE PLUMBIMNG CODE OF NY. STATE CHAPTERS 25 THROUGH 32. THE ELECTRICAL CODE OF NY. STATE, CHAPTERS 34 THROUGH 42

ELECTRICAL NOTES:

THE PROPOED DWELLING HAS BEEN DESIGNED TO BE IN CONFORMANCE WITH THE 2015 INTERNATION RESIDENTIAL CODE 2ND PRINTING ADOPTED & AMENDED BY NEW YORK STATE AND THE 2017 NEW YORK STATE CUPPLEMENT, CHAPTER 33 THROUGH 43

ENERGY NOTE:

TO THE BEST OF MY KNOWLEDGE, BELIEF AND PROFESSIONAL JUGDEMENT, THESE PLANS AND/OR SPECIFICATIONS ARE IN COMPLIANCE WITH: THE 2015 INTERNATIONAL ENERGY CONSERVARTION CODE WITH AMENDMENTS AS PER 2016 SUPPLEMENT TO THE NEW YORK STATE ENERGY CONSERVATION CONSTRUCTION CODE (REVISED AUGUST 2016)

NOTE:

- ALL PLUMBING WORK TO BE DONE AS PER CODE. FIXTURES TO HAVE INDIVIDUAL SHUT OFF VALVE.
- FIXTURES TO BE PROPERLY VENTED.

NOTE:

- ALL DIMENSIONS AND WORK QUANTITIES SHALL BE VERIFIED IN THE FIELD BY THE CONTRACTOR, AND RECEIVED DISCREPANCIES SHALL BE IMMEDIATELY REPORTED TO THE ARCHITECT.
- MINOR DETAILS NOT SHOWN OR SPECIFIED BUT NECSSARY FOR PROPER CONSTRUCTION OF ANY PART OF THIS WORK SHALL BE INCLUDEDAS IF THEY WERE INDICATED ON THE PLANS.
- NO WORK SHALL BE COMMENCE UNTIL PLANS ARE APPROVED AND PERMIT SECURED FROM THE LOCAL DEPARTMENT OF **BUILDINGS**



Project Name

SEAL:

PROJECT INFO: PROJECT NO

SI ARCHITECTURE GROUP LLC SI ARCHITECTURE GROUP LLC

(123) 456- 7891 ABC STREET, CITY, STATE, ZIP CODE

CLIENT INFO:

CLIENT NAME


PROFESSOR CLEMENS


IHSANULLAH SAIBAY


DRAWN BY: **REVISIONS:**


NOTES & DETAILS

SCALE:

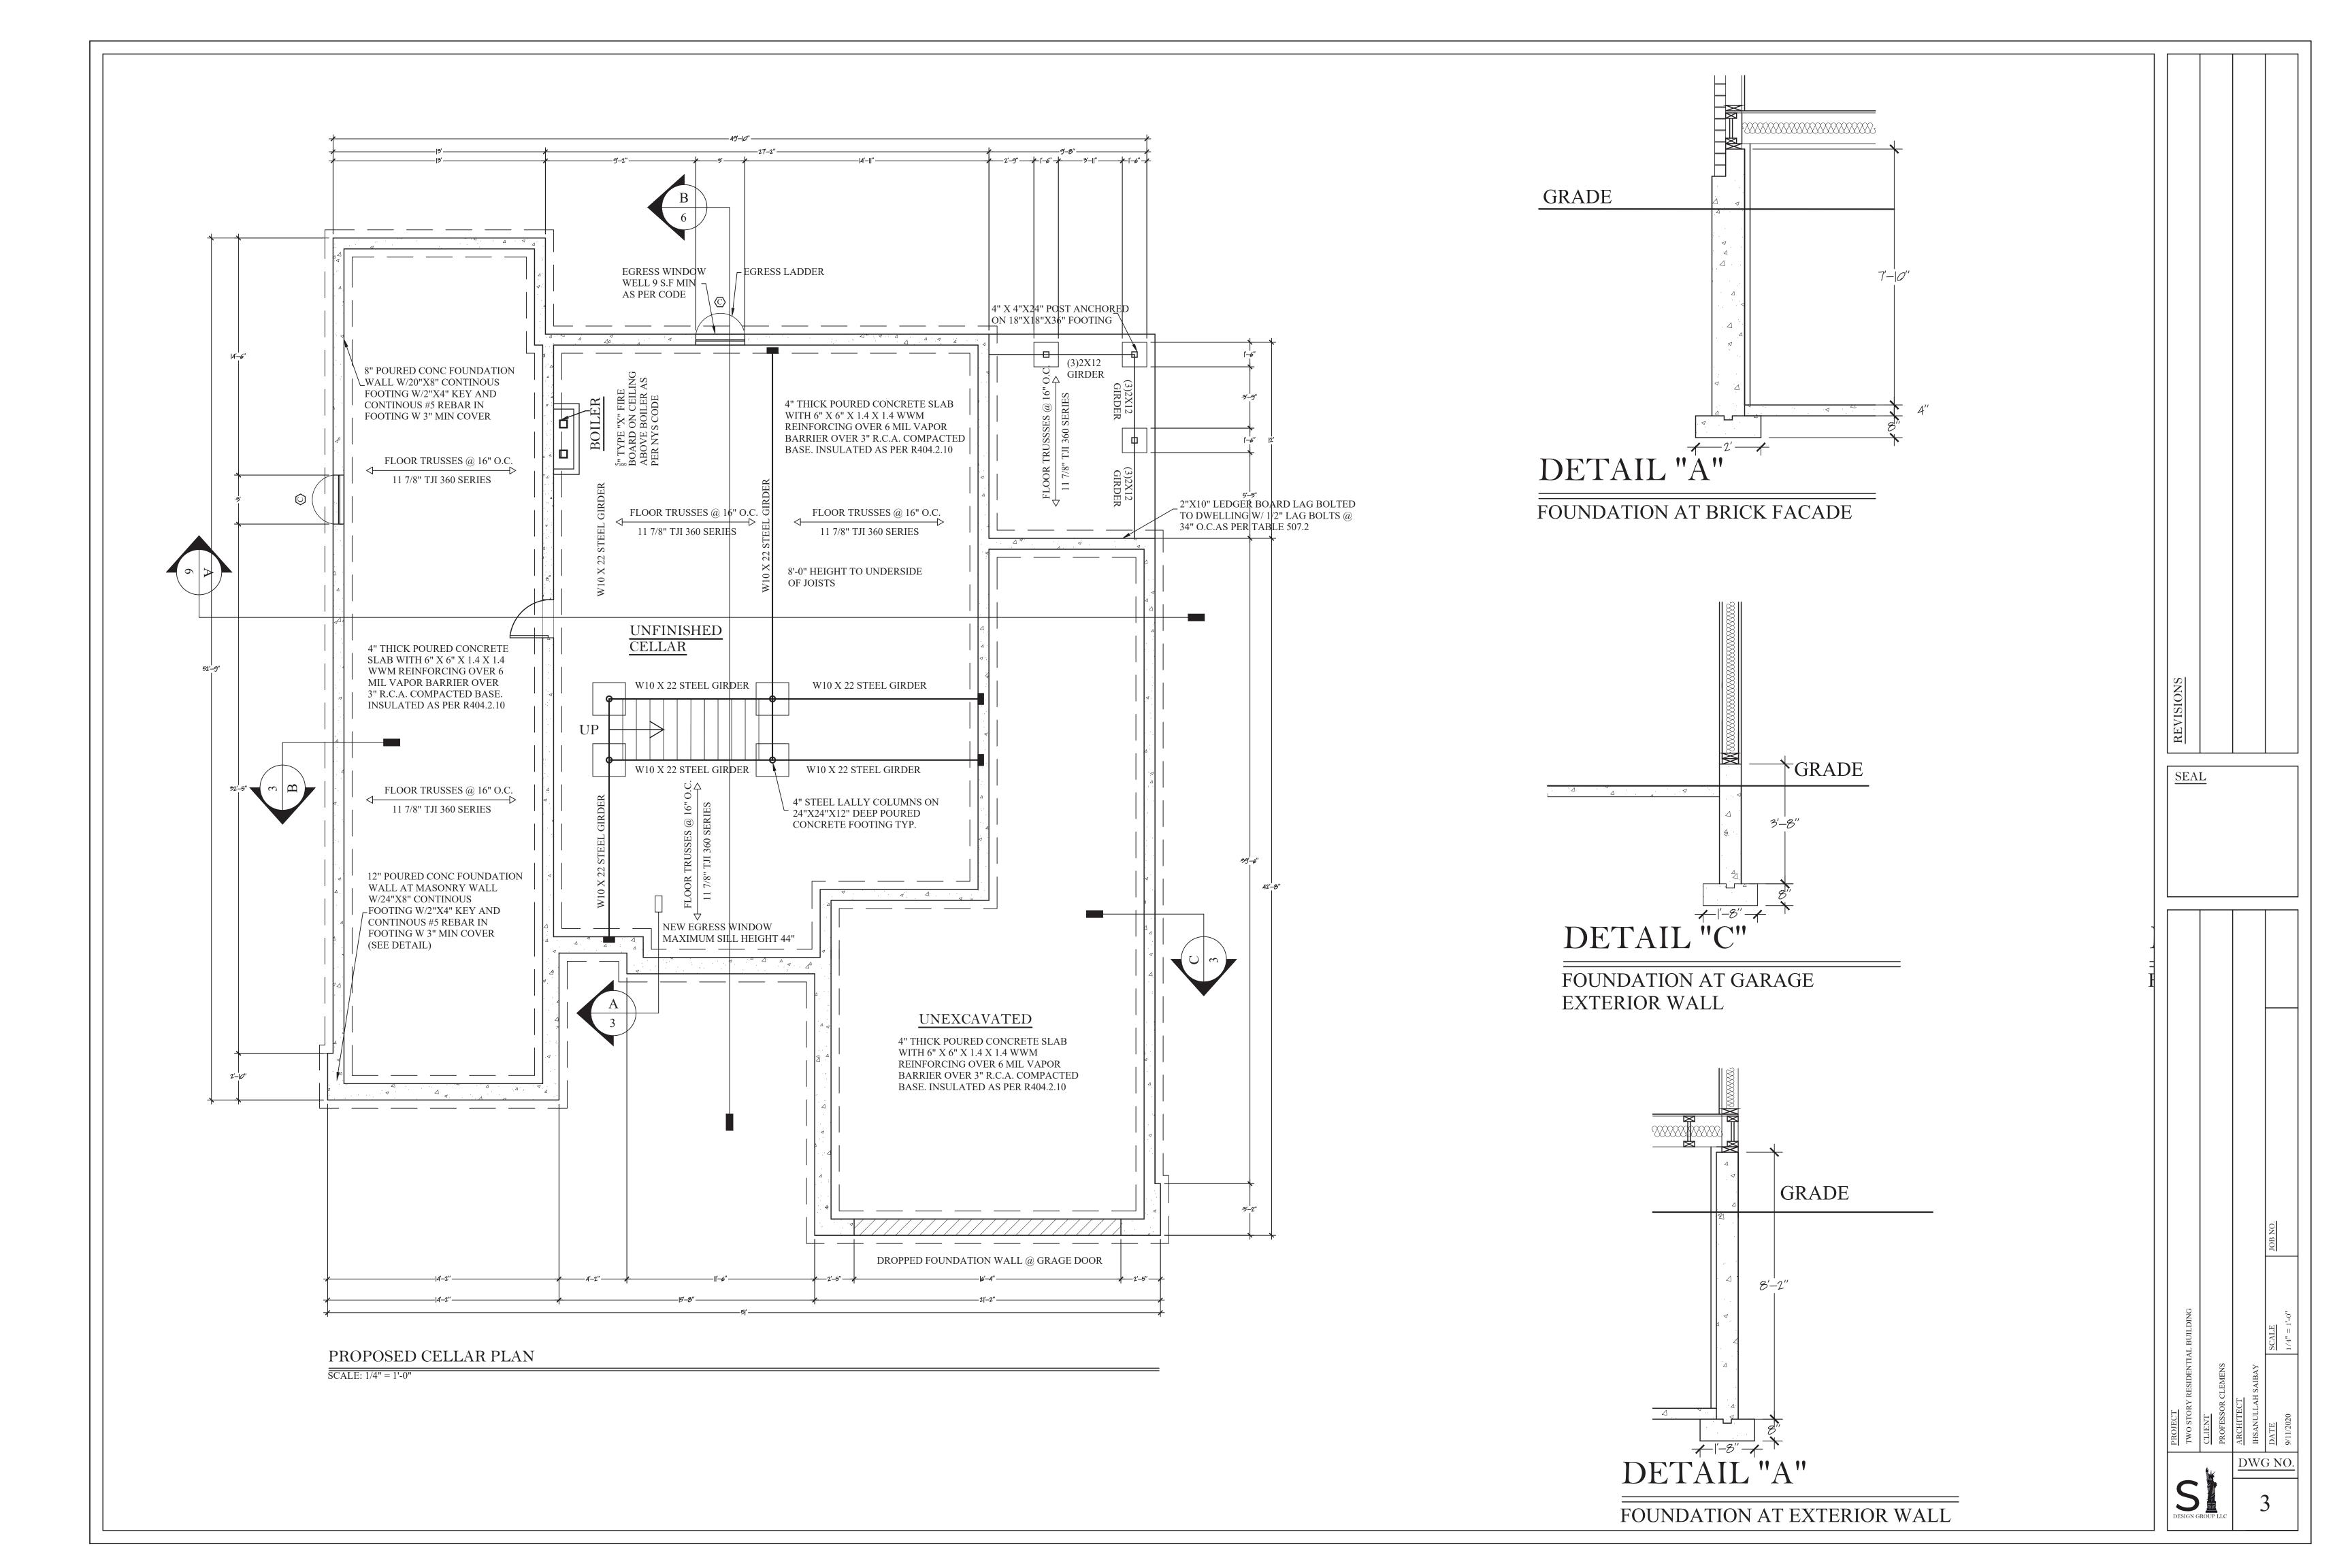


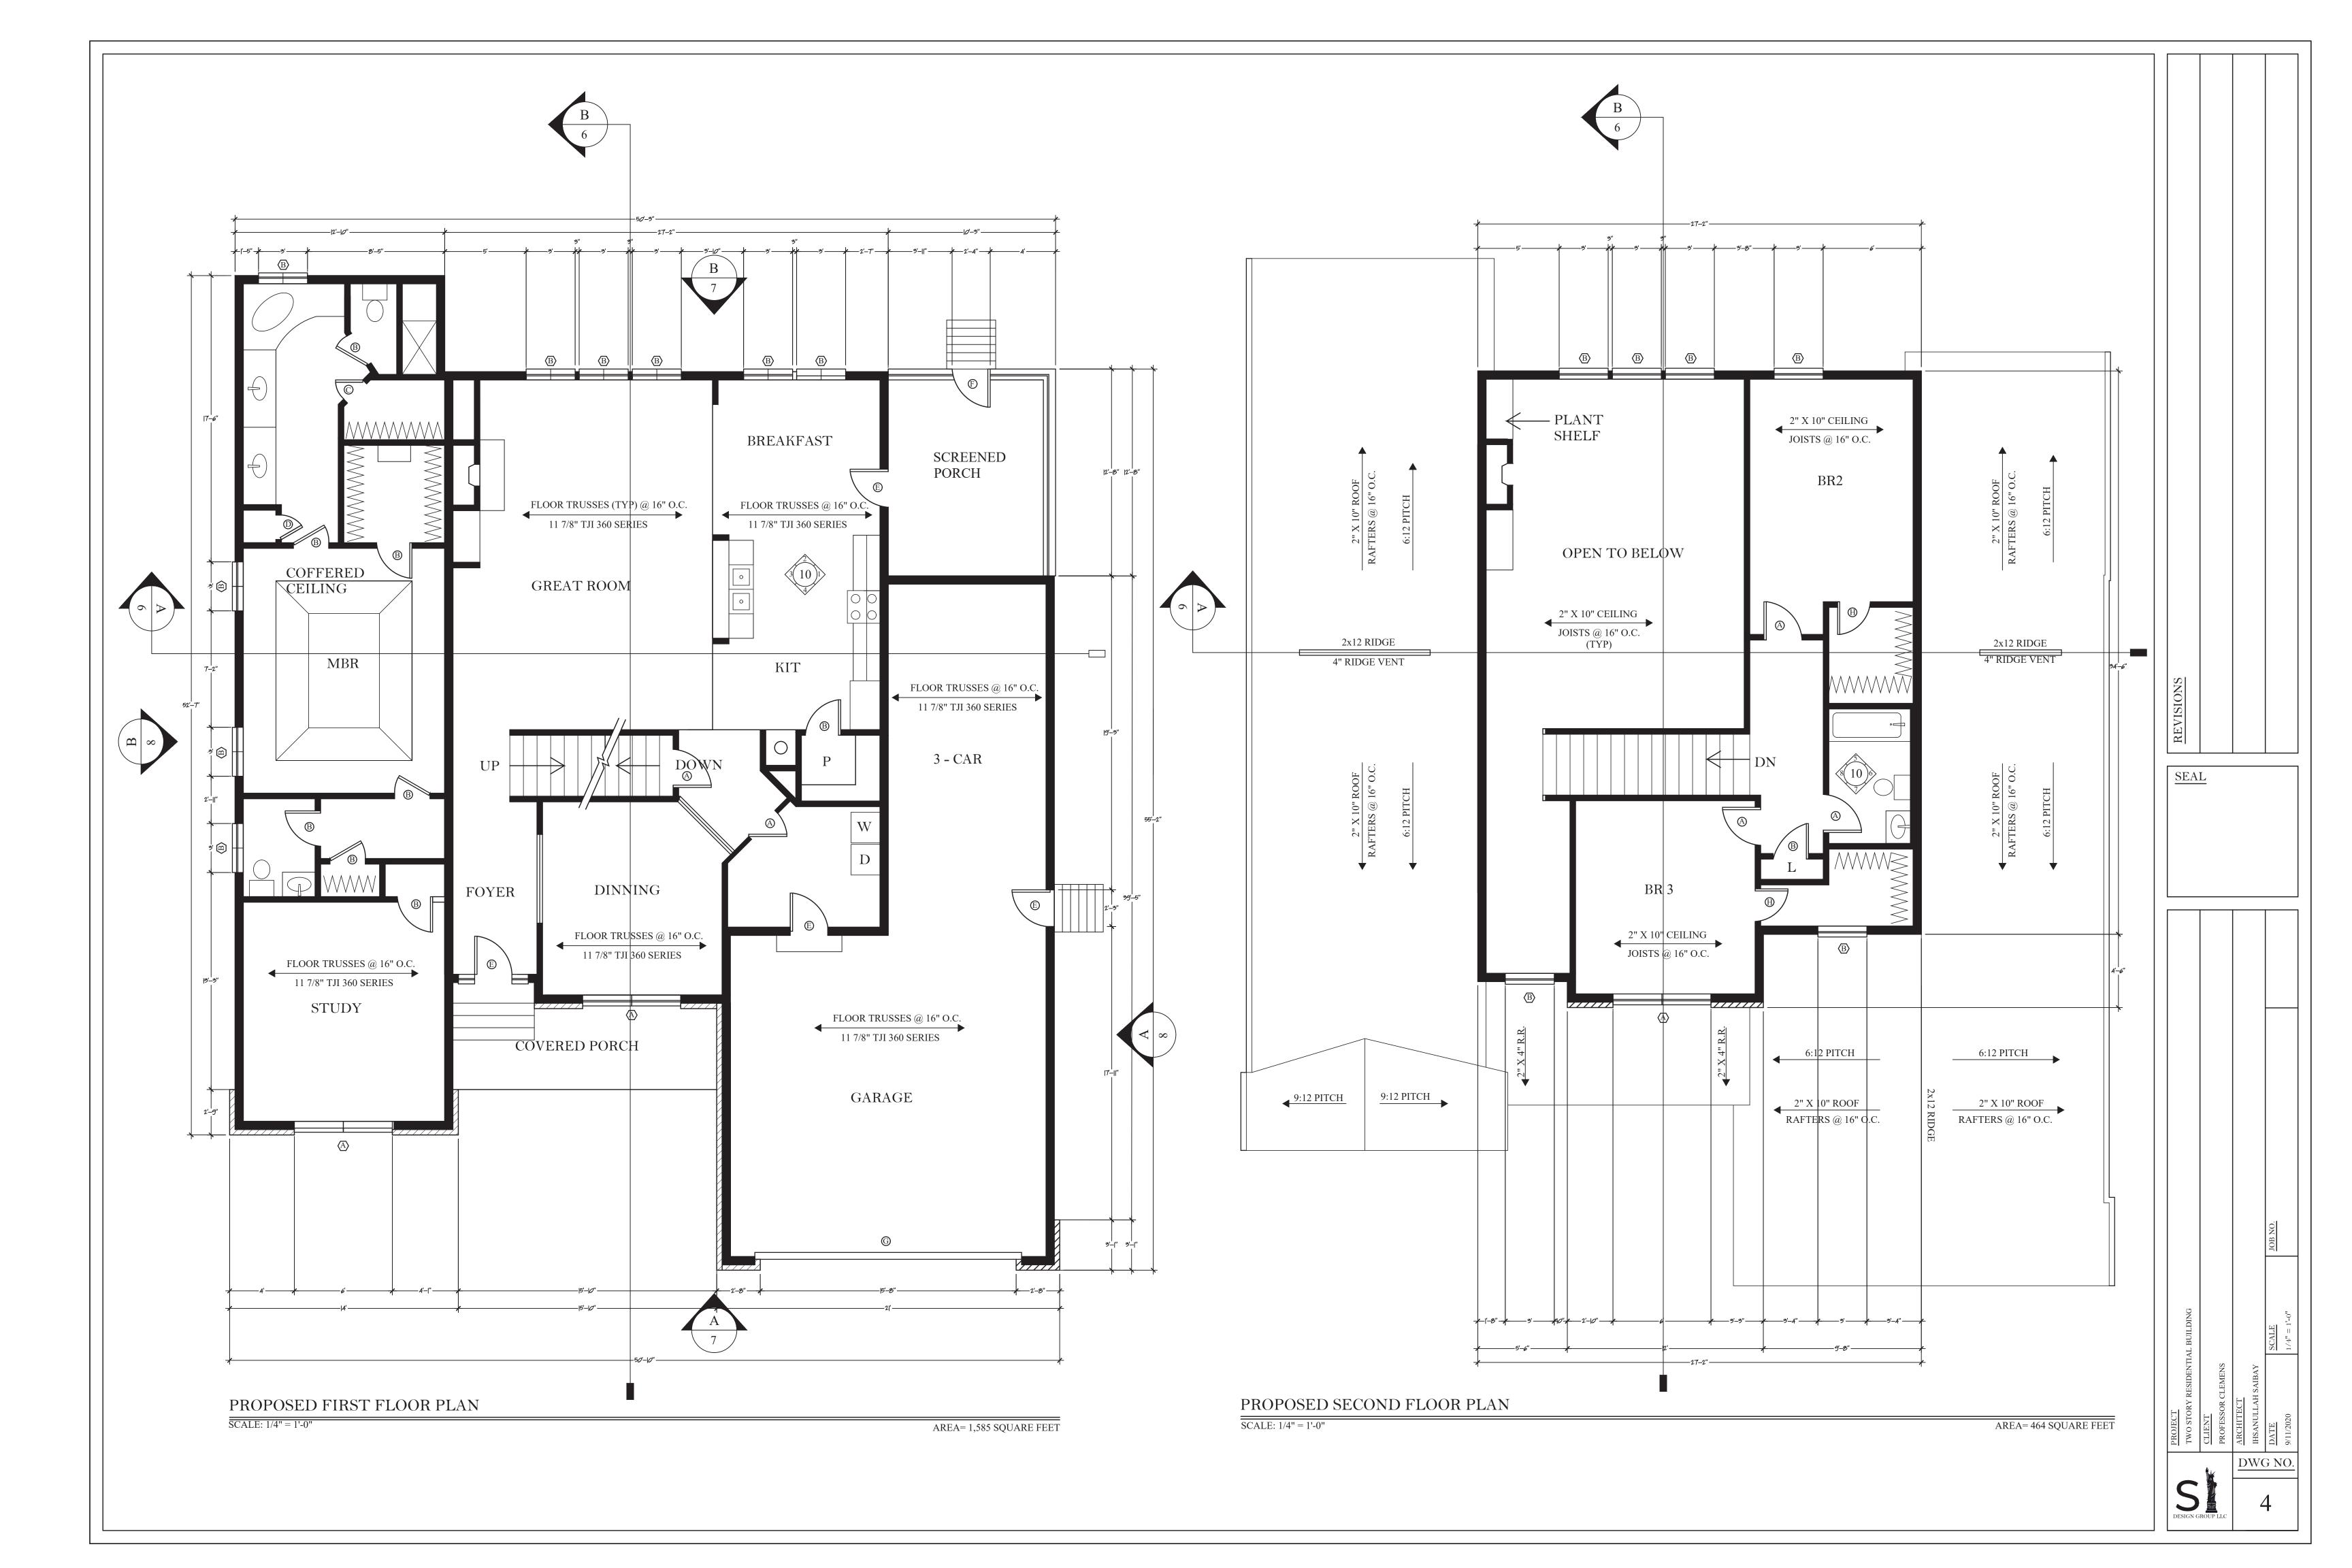


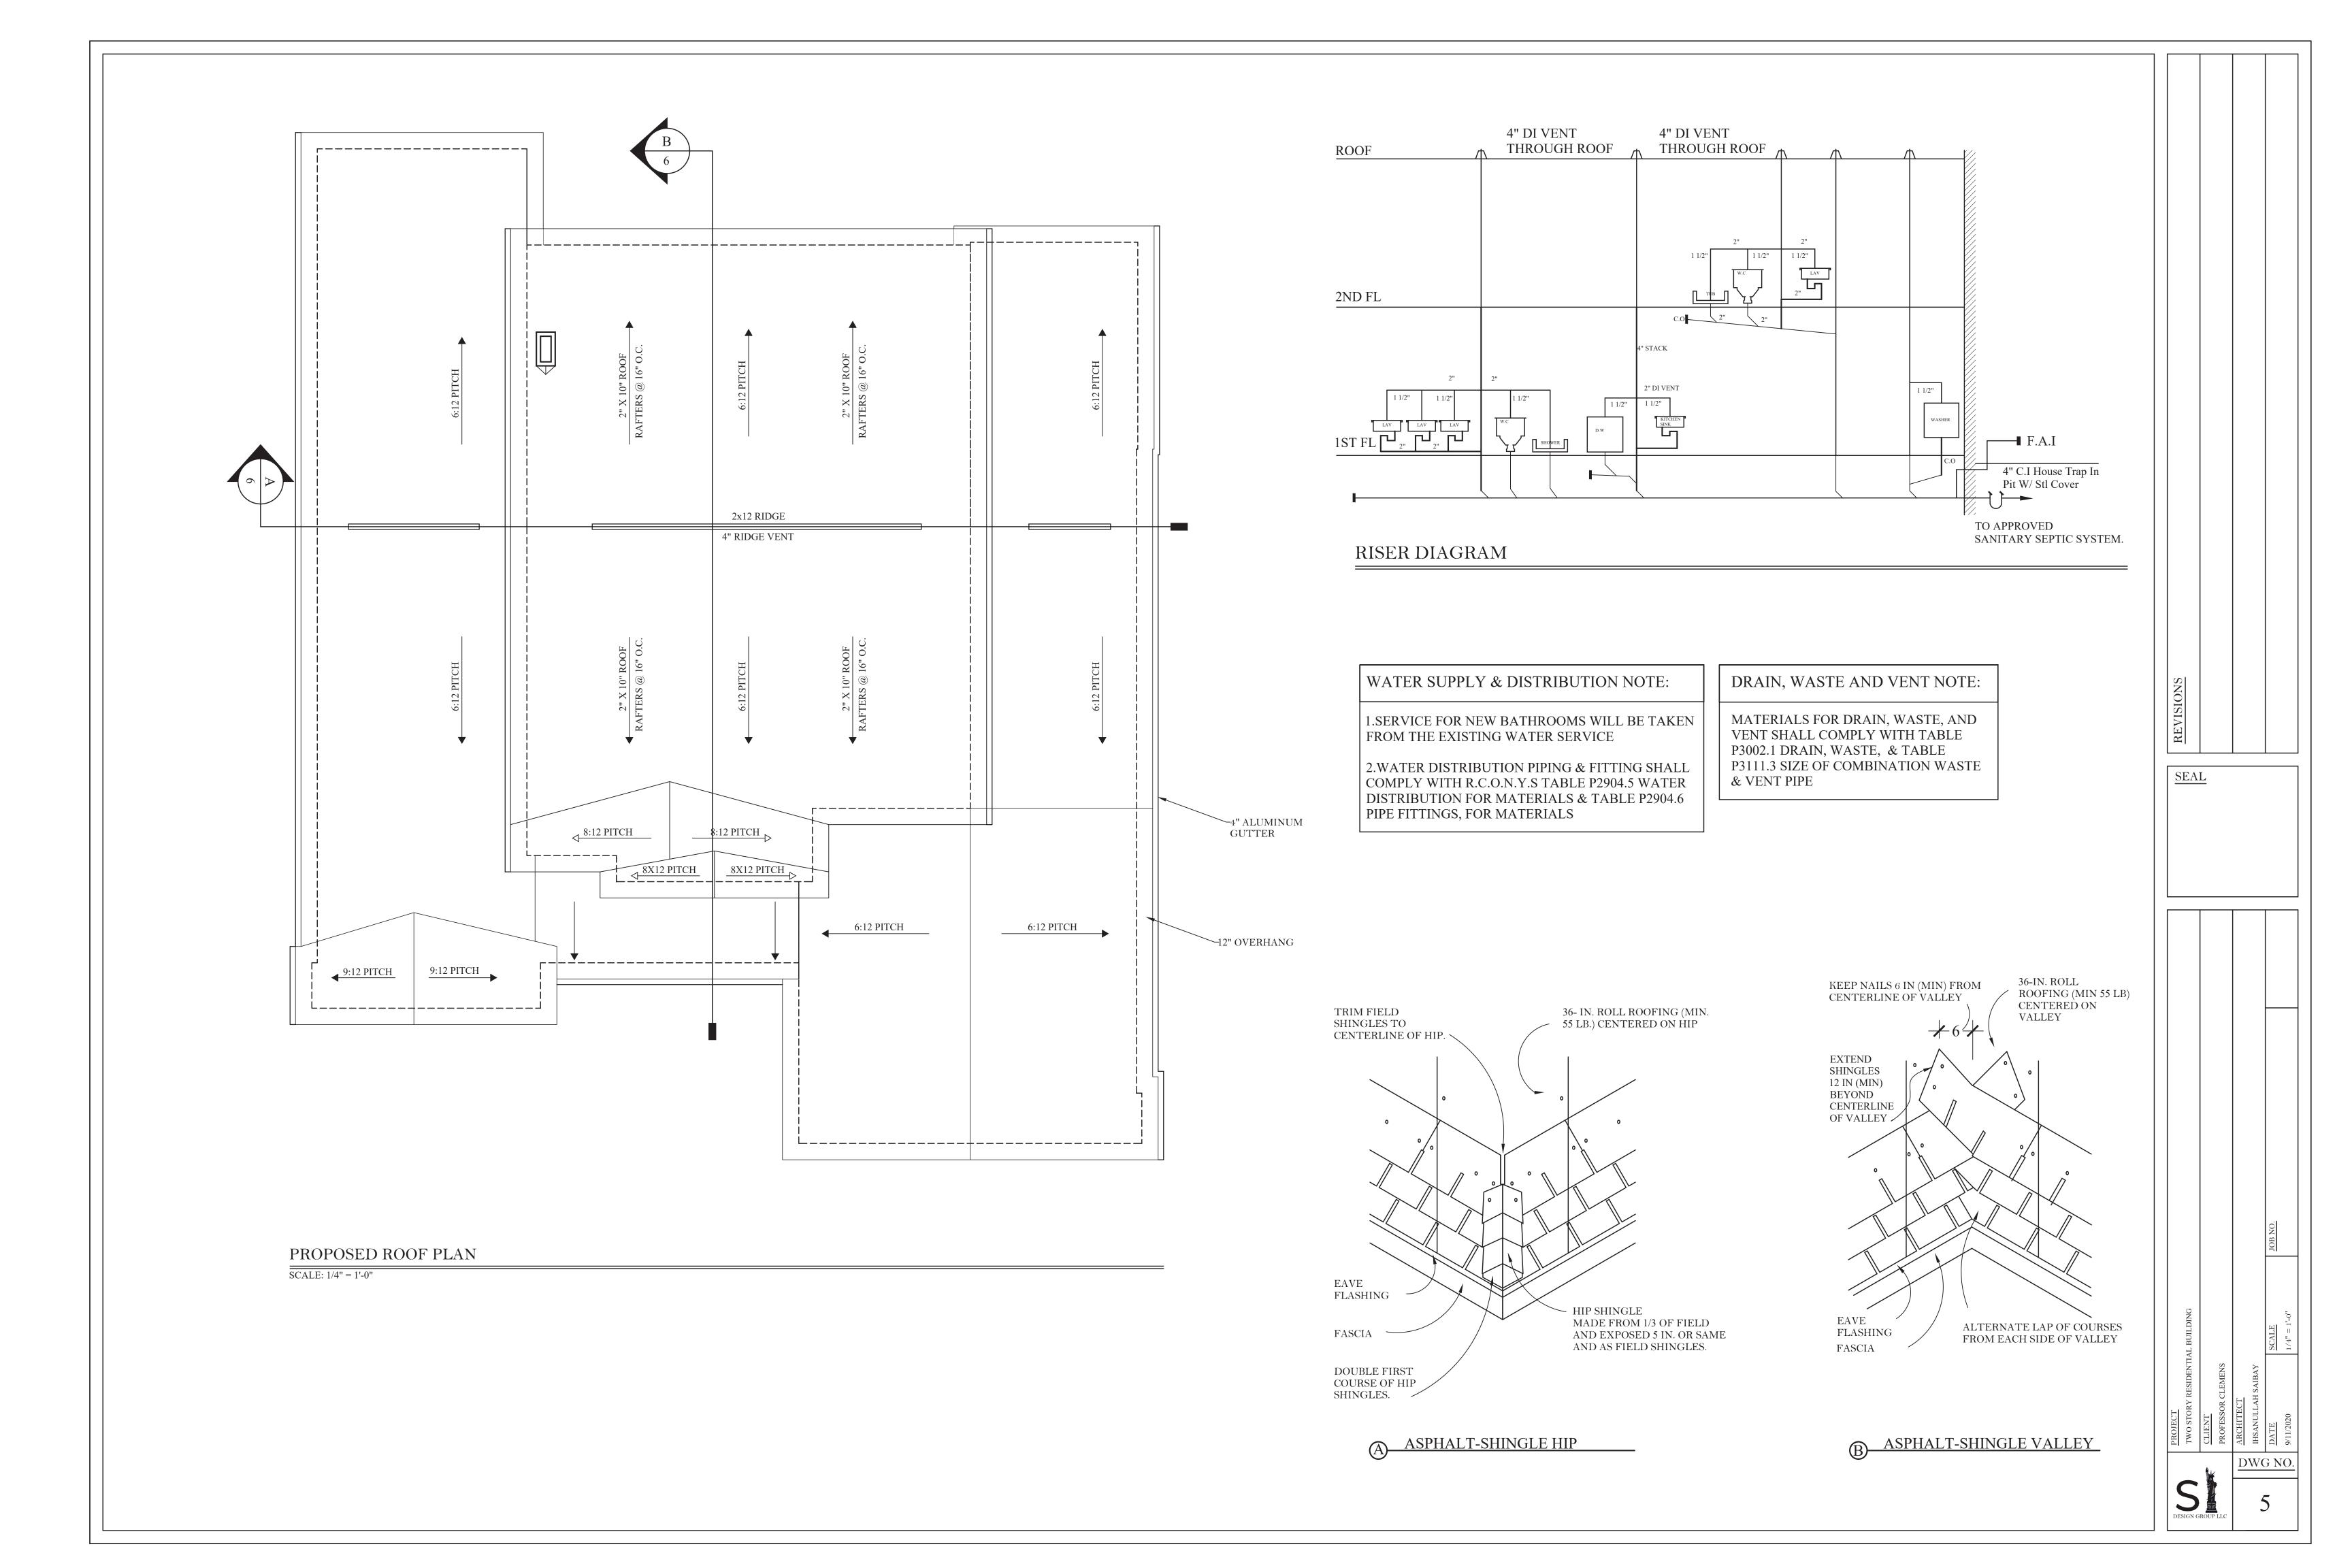


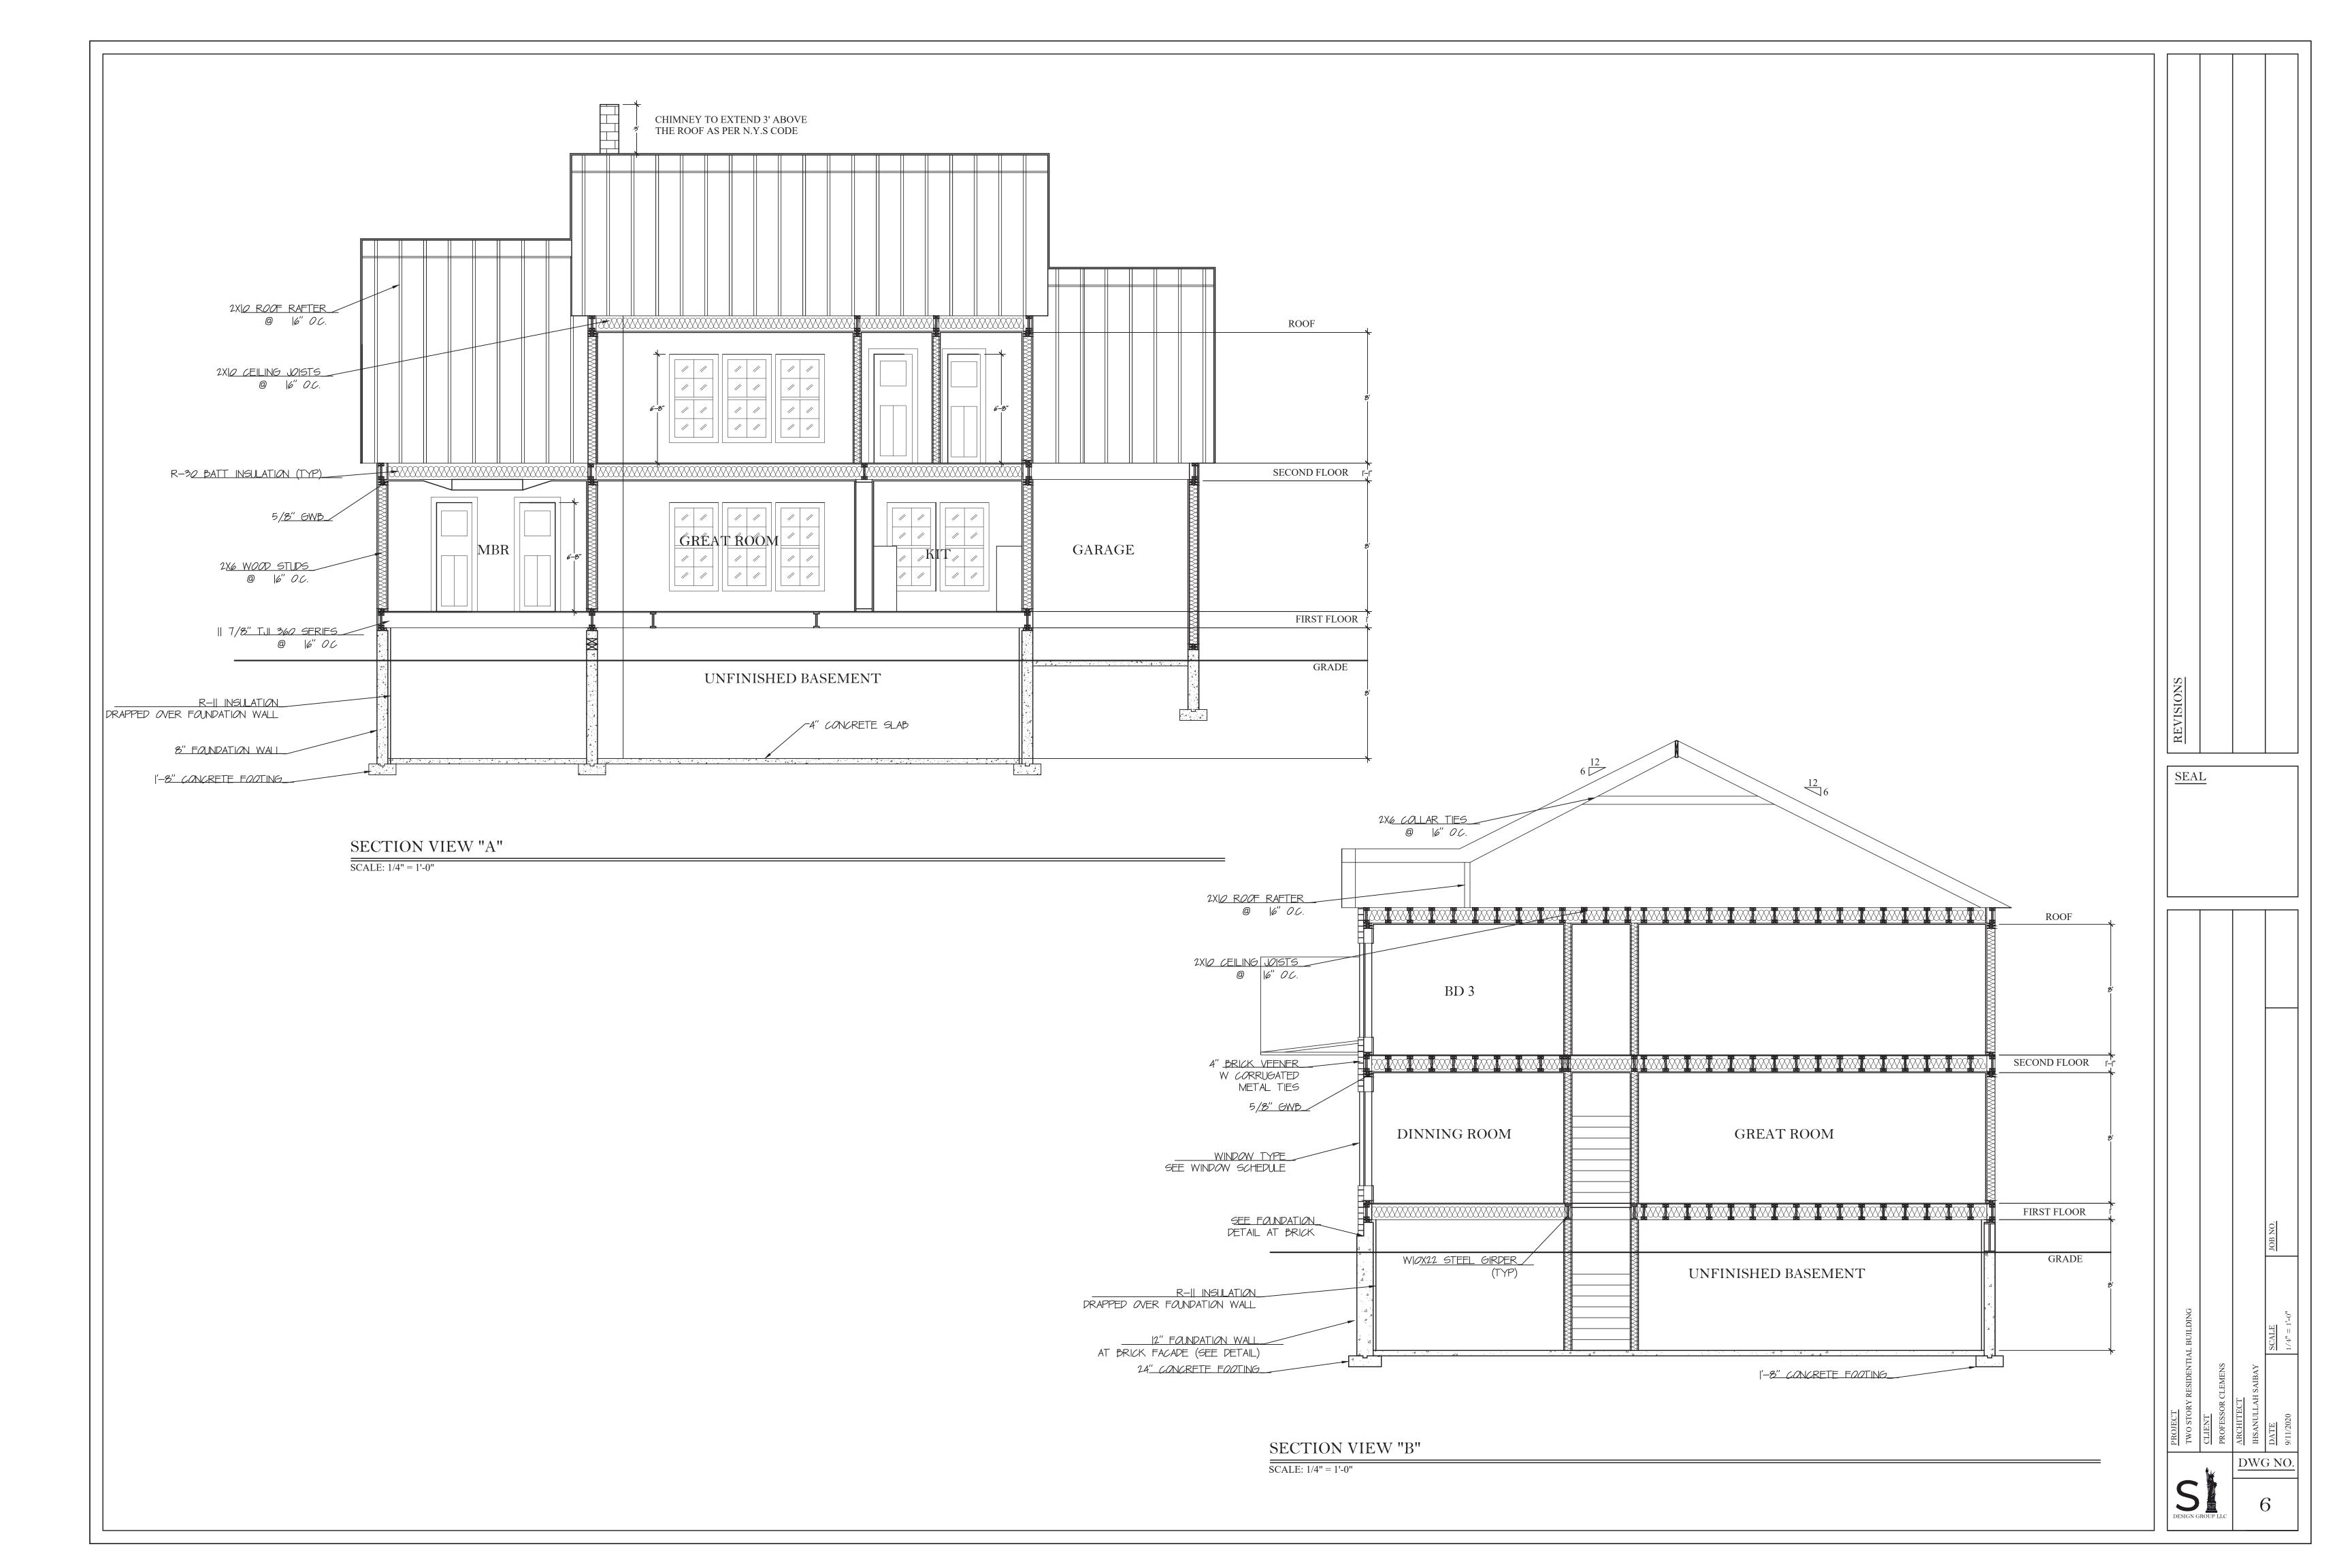





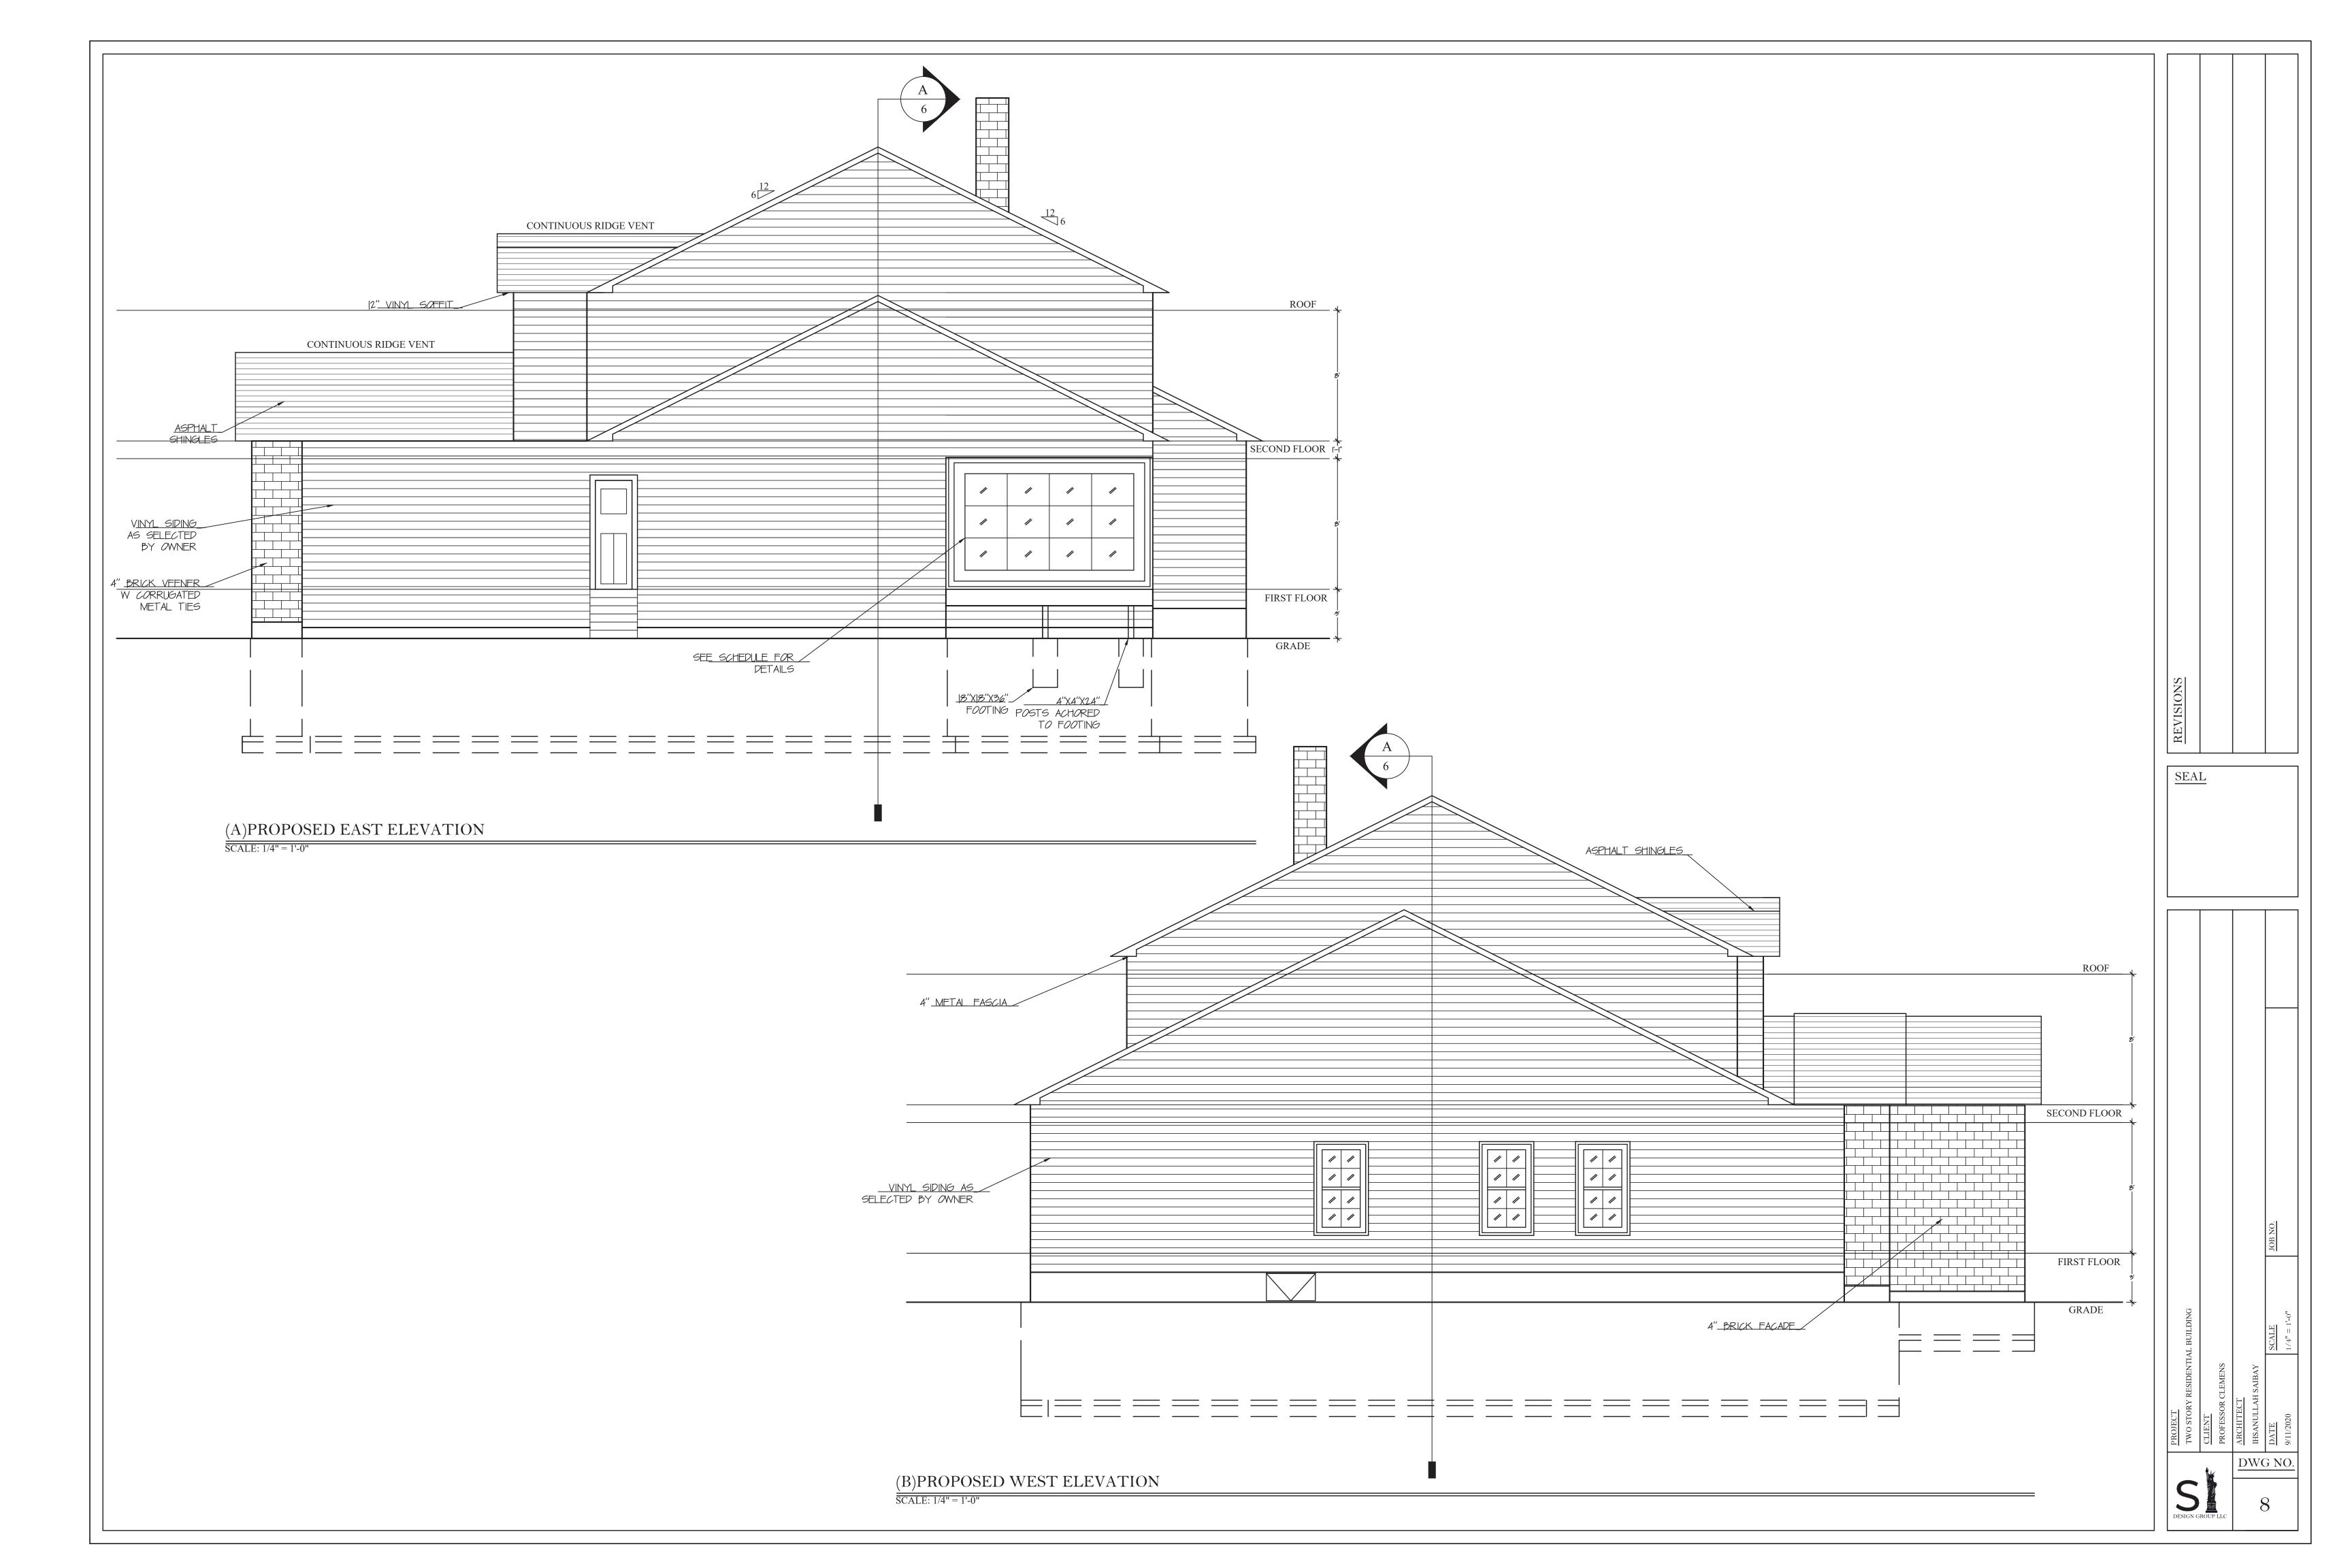

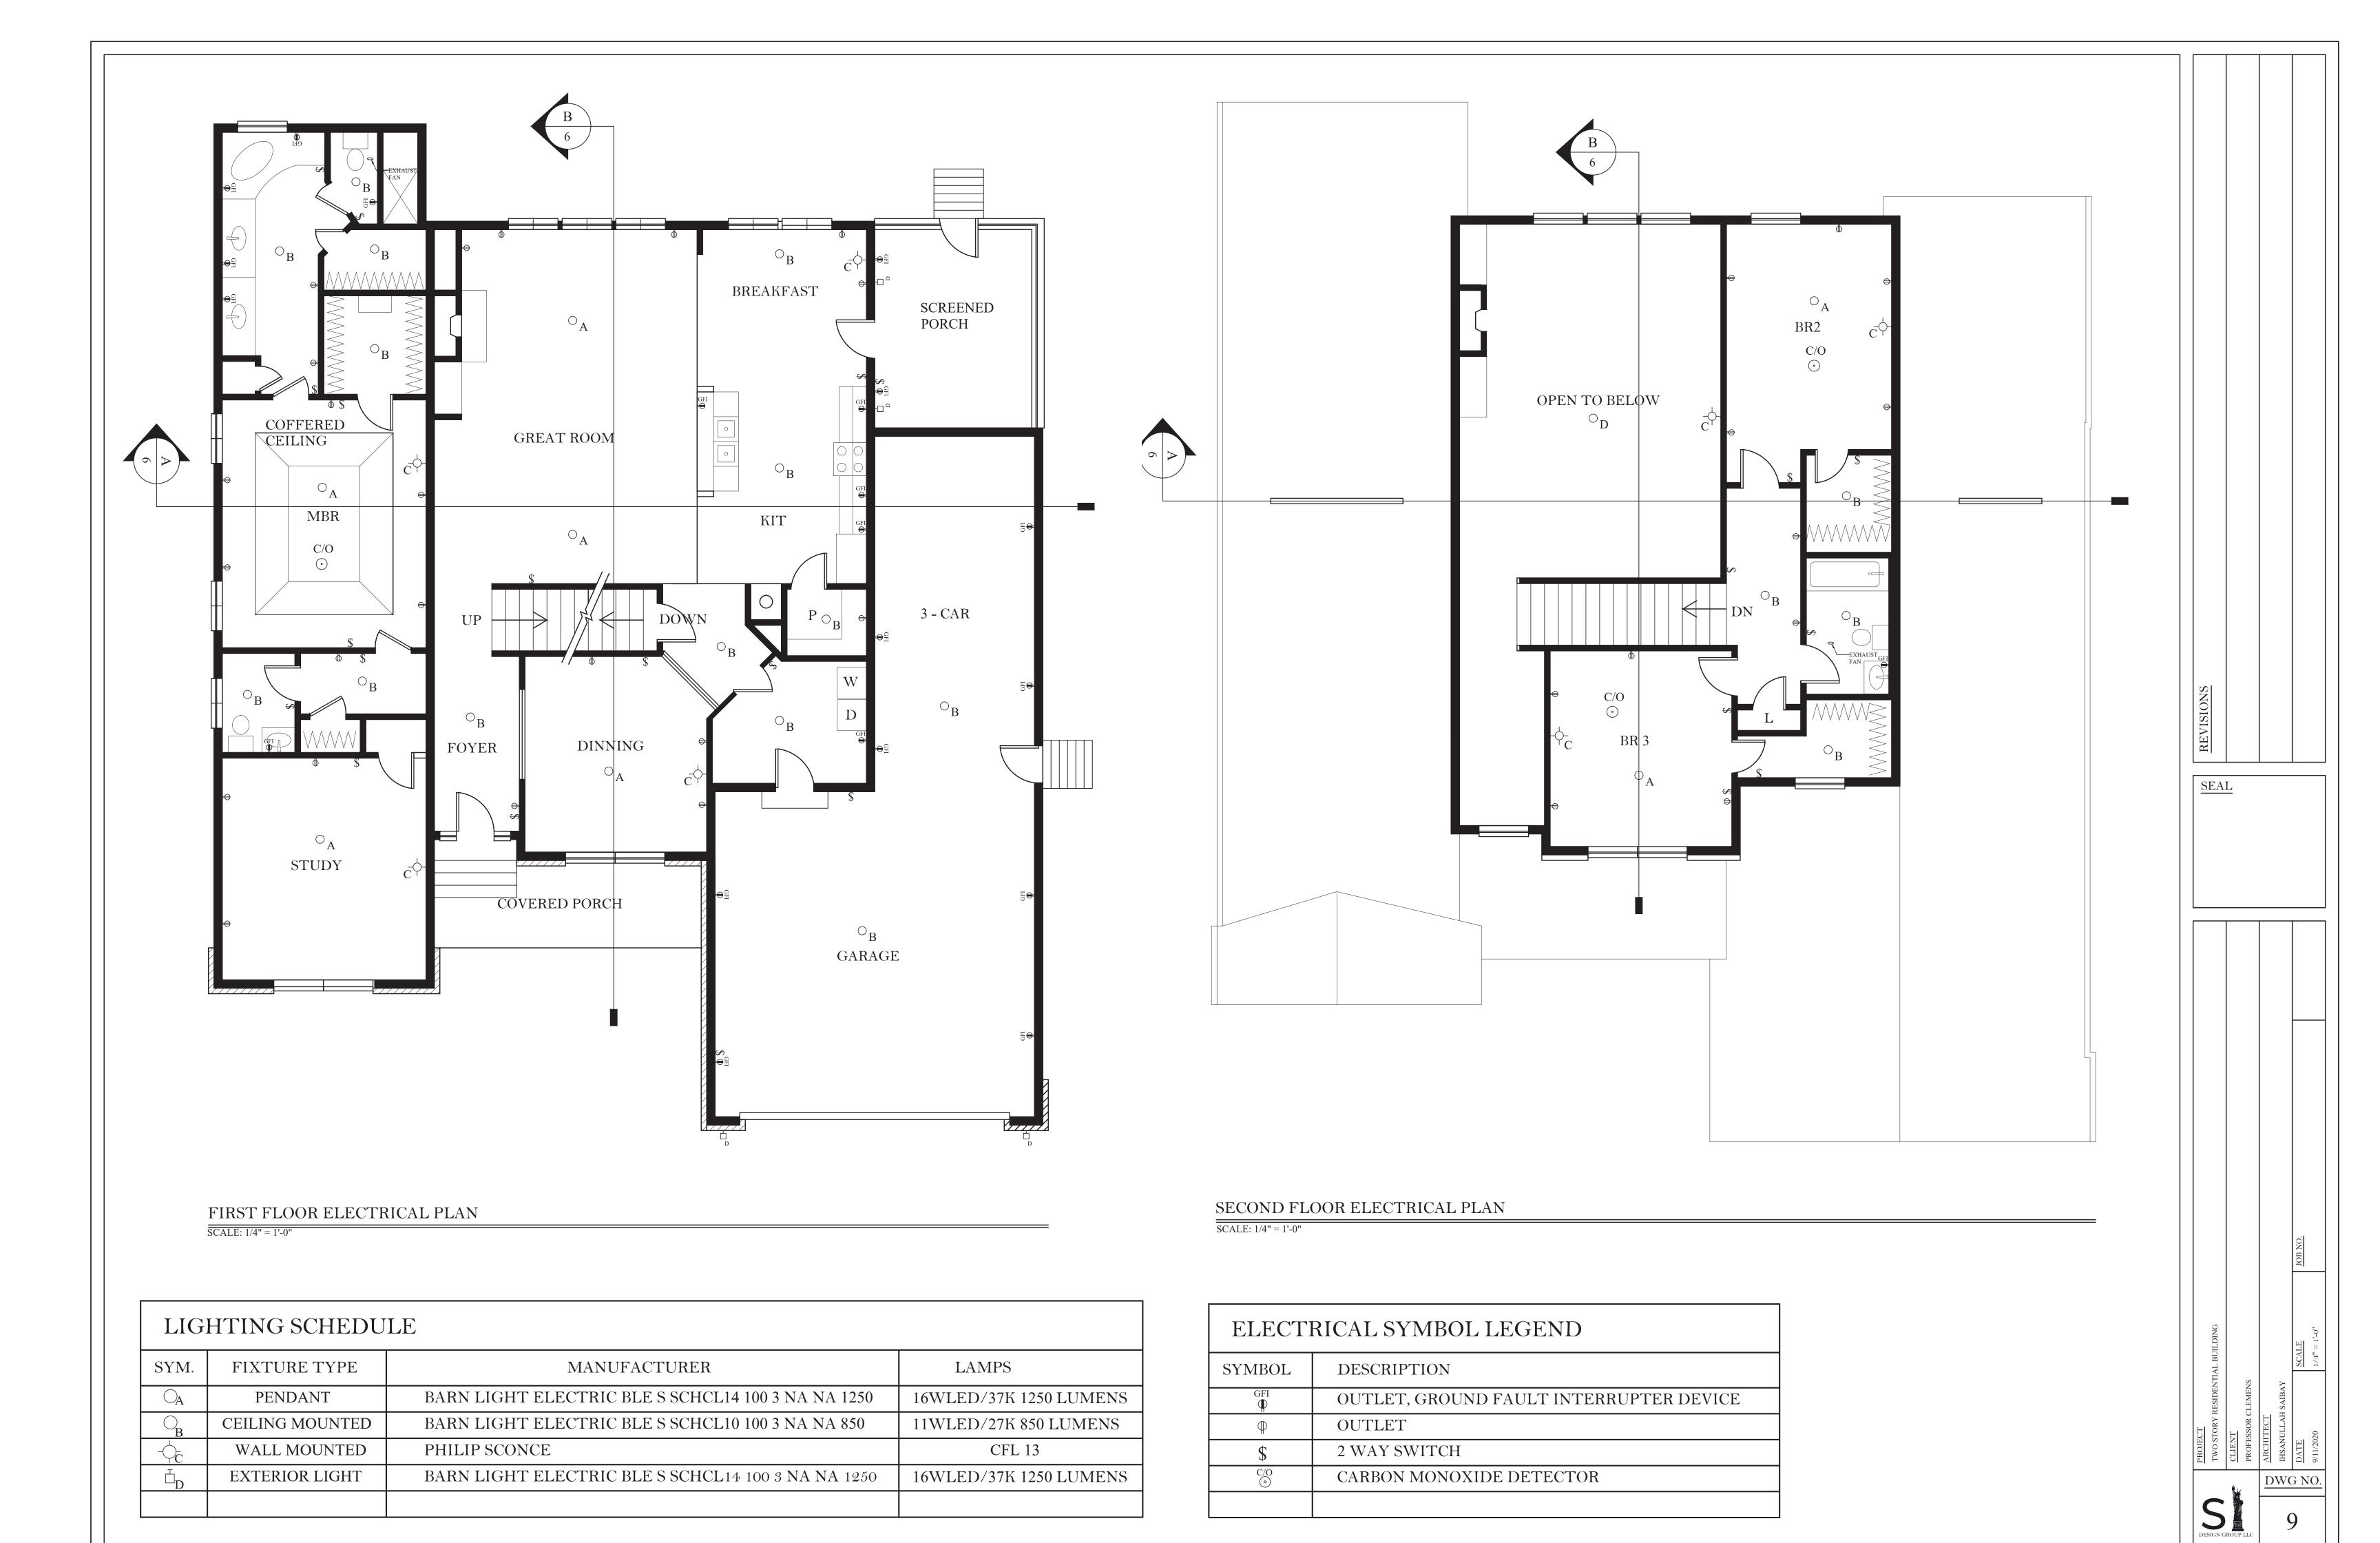

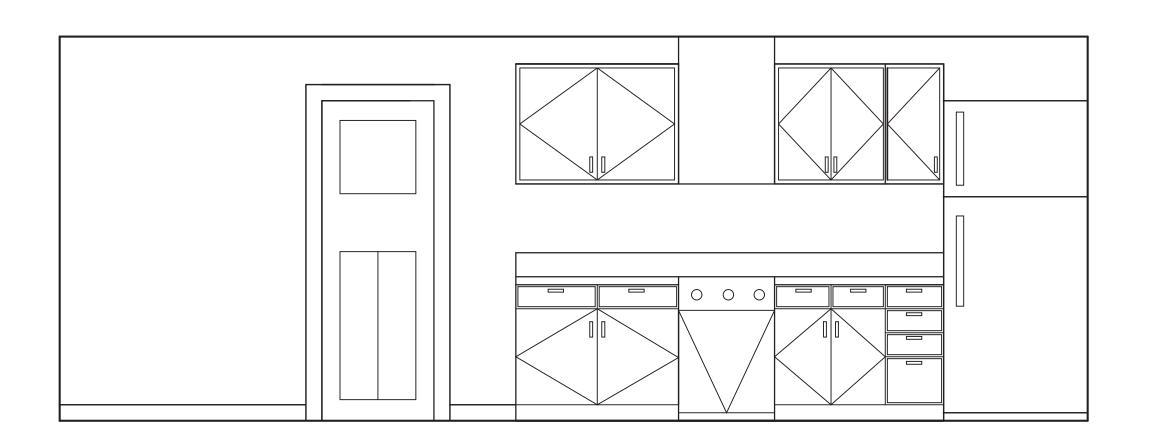

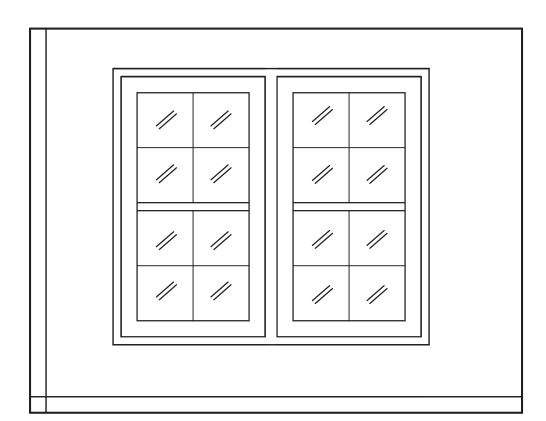

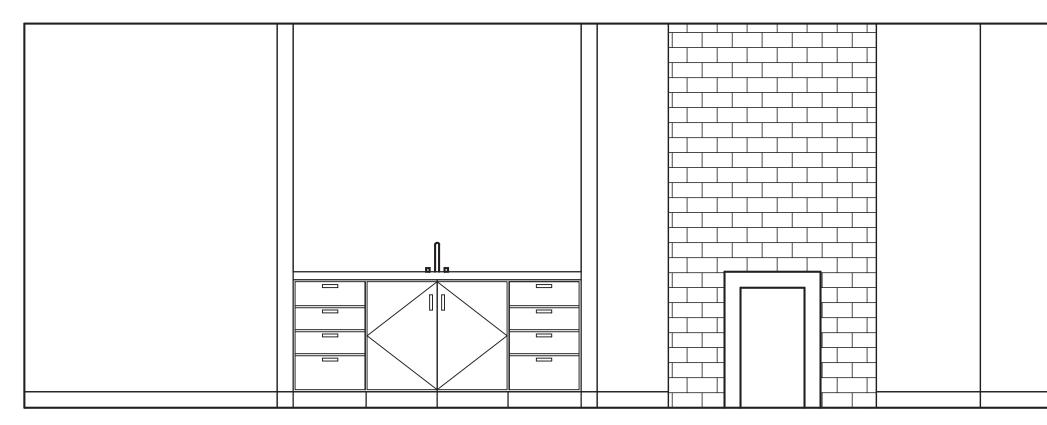

(1) ELEVATION (E)


SCALE: 1/2" = 1'-0"


(2) ELEVATION (N)


SCALE: 1/2" = 1'-0"


(3) ELEVATION (W)


SCALE: 1/2" = 1'-0"

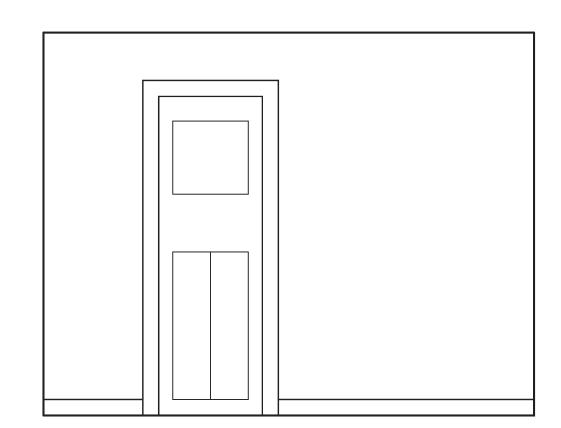

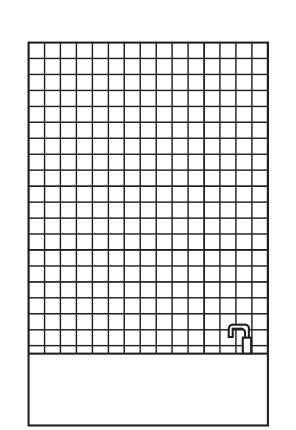

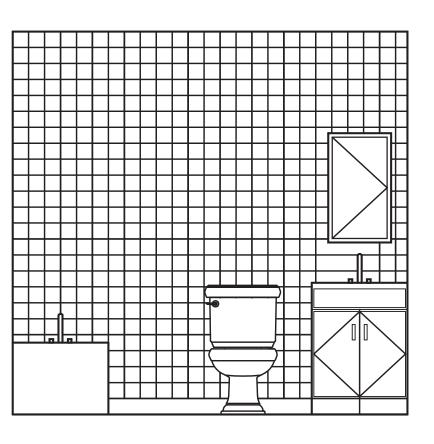

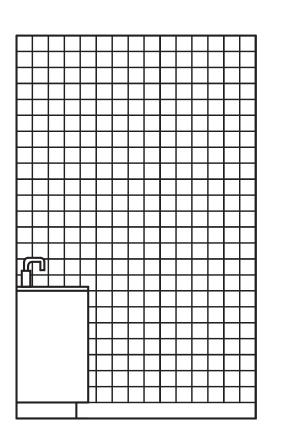

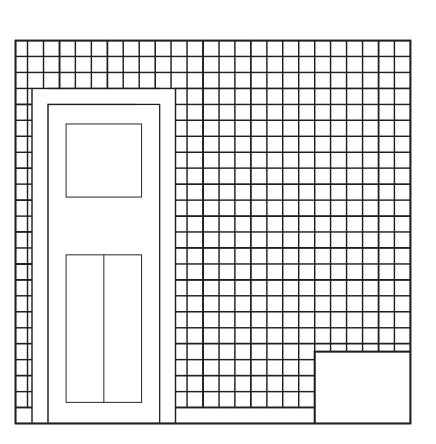

(4) ELEVATION (S)

SCALE: 1/2" = 1'-0"



SCALE: 1/2" = 1'-0"



SCALE: 1/2" = 1'-0"

(7) ELEVATION	(S)
---------------	-----

 $\overline{\text{SCALE: } 1/2" = 1'-0"}$

(8) ELEVATION	(W))
---------------	-----	---


SCALE: 1/2" = 1'-0"


DES	SIGN G	ROUP	LLC		1	Ο	
		1	,	D	W(3 N	Ю
LIOSECI	TWO STORY RESIDENTIAL BUILDING	CLIENT	PROFESSOR CLEMENS	ARCHITECT	IHSANULLAH SAIBAY	$\overline{ ext{DATE}}$	9/11/2020
	AL BUILDING					SCALE	1/4" = 1'-0"
						JOB NO.	

SEAL

DOOR SCHEDULE		NOTE: ALL GLASS DOOR AND GLASS SIDELITES TO BE ANDERSON STORM WATCH IMPACT RESISTANT UNITS		
MARK	SIZE (NOMINAL)	TYPE	COMMENTS	
A	2'-4" X 6'-8" X 1 3/4	WOOD DOOR	3 PANEL DOOR W LATCH	
<u>B</u>	2'-2" X 6'-8" X 1 3/4	WOOD DOOR	3 PANEL DOOR W LATCH	
©	1'-8" X 6'-8" X 1 3/4	WOOD DOOR	3 PANEL DOOR W LATCH	
(D)	1'-6" X 6'-8" X 1 3/4	WOOD DOOR	3 PANEL DOOR W LATCH	
E	2'-4" X 6'-8" X 1 3/4	ALUMINUM DOOR	3 PANEL DOOR W LATCH	
F	2'-4" X 6'-8" X 1 3/4	GLASS/ALUMINUM	STORMWATCH IMPACT RESIS	
G	16'-4" X 6'-8" X 1 3/4	OVERHEAD DOOR	INSULATED GARAGE DOOR	
\bigcirc	2'-0" X 6'-8" X 1 3/4	WOOD DOOR	3 PANEL DOOR W LATCH	


WINDOW SCHEDULE NOTE: ALL WINDOWS TO BE ANDERSON STORM WATCH IMPACT RESISTANT UNITS				
MARK	SIZE (NOMINAL)	TYPE/ANDERSEN#	COMMENTS	
(A)	6'-0" X 5'-5"	DOUBLE HUNG	U-32	
B	3'-0" X 5'-5"	DOUBLE HUNG	U-32	
(C)	3'-0" X 1'-8"	HOPPER WINDOW	U-32 WINDOW WELL WINDOW	

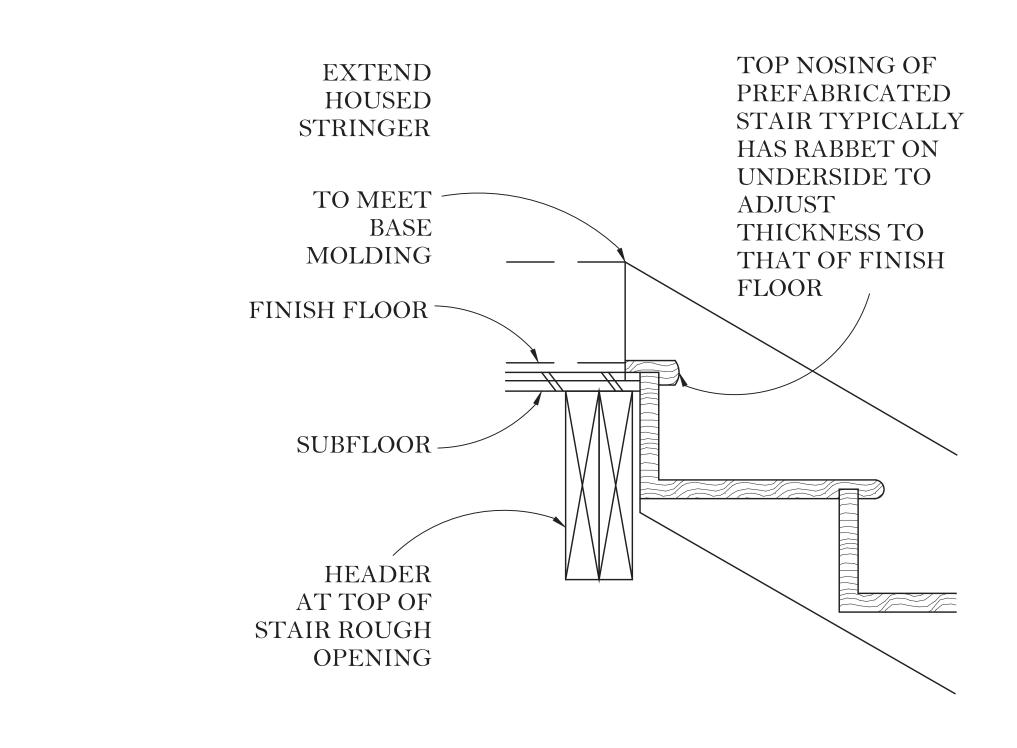

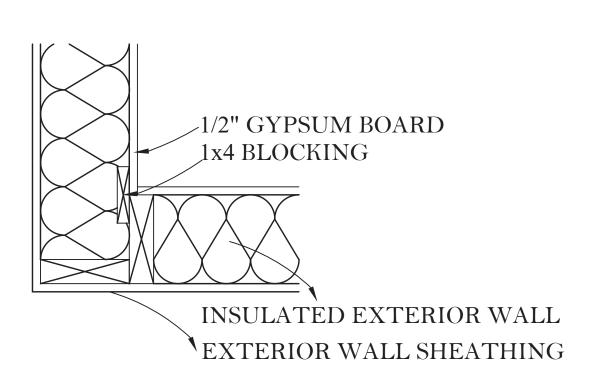






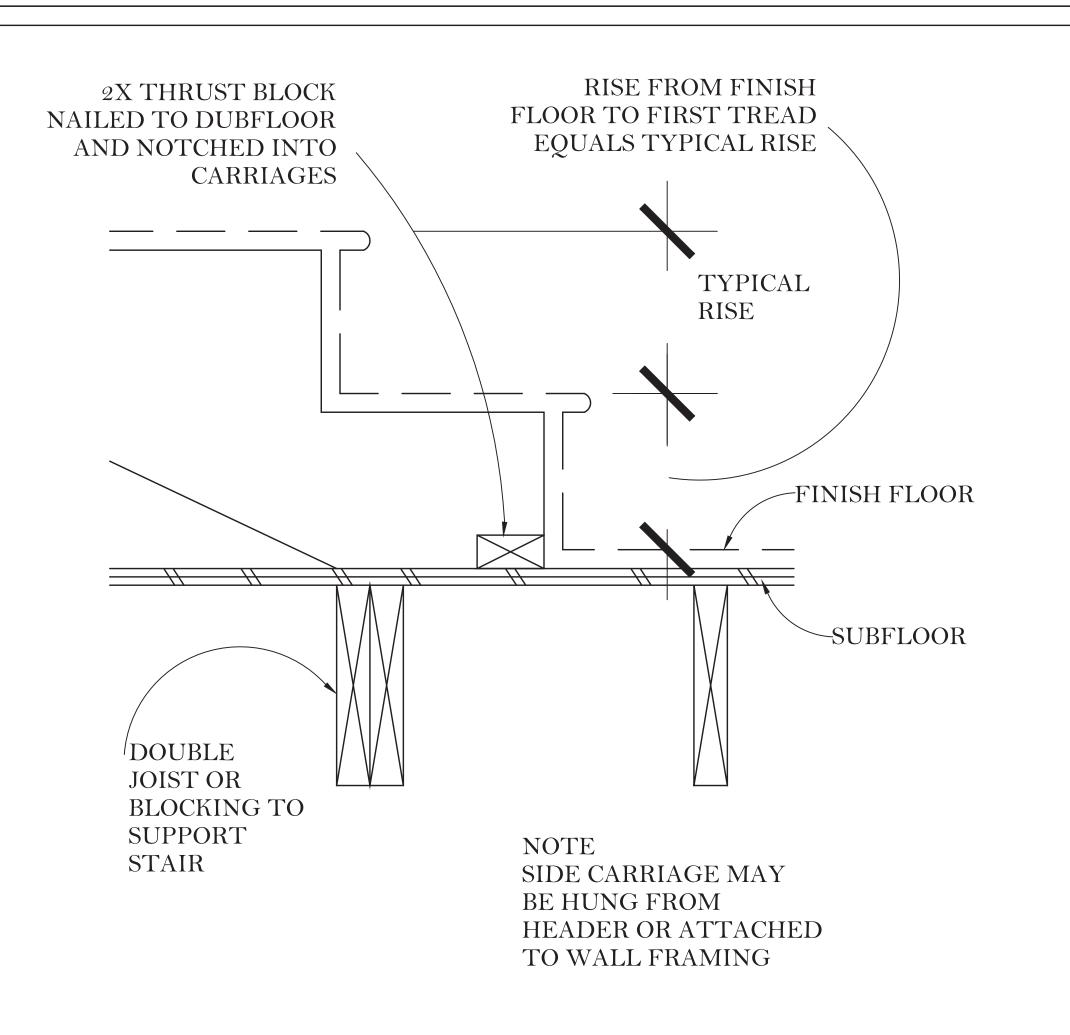

A BOTTOM OF CARRIAGE/FLOOR
Single Flight

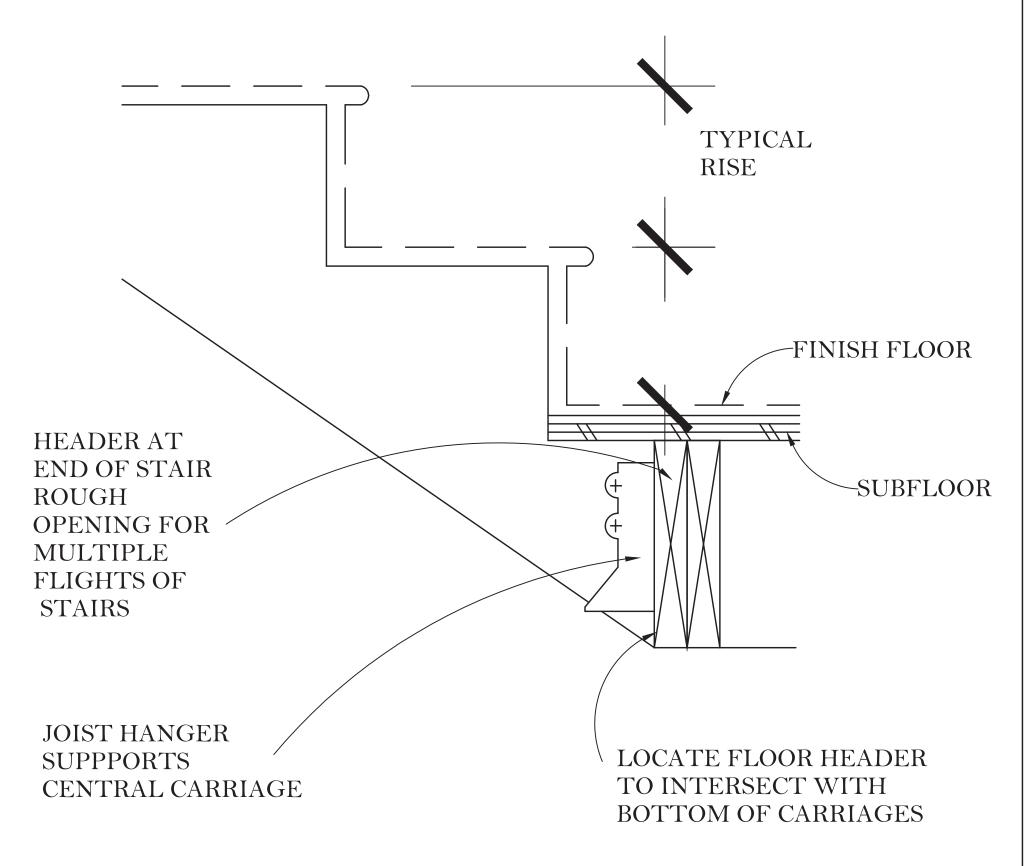

\bigcirc	BOTTOM OF CARRIAGE/FLOOR
D	Intermediate Flight

SEAL